




**MATERIAL KEYNOTES**

0.0	EXISTING CONDITIONS	
0.1	EXISTING TREE TO REMAIN AND PROTECT	1/SHEET L2.01
0.2	EXISTING TREE TO BE REMOVED	
0.3	EXISTING SHRUB AREA	
1.0	PAVING	
1.1	CRUSHER FINES	4/SHEET L5.01
2.0	SITE FURNISHINGS & SITE ELEMENTS	
2.1	BENCH (CAMPUS STANDARD)	8/SHEET L5.01
3.0	PLANTING	
3.1	DECIDUOUS TREE PLANTING	1/SHEET L5.01
3.2	SHRUB PLANTING	2/SHEET L5.01
3.3	GROUNDCOVER / PERENNIAL PLANTING	4/SHEET L5.03
3.5	SHREDDED FIR FIBER MULCH	5/SHEET L5.03
3.6	STEEL EDGER	8/SHEET L5.03
3.7	NATIVE GRASS AREA	
3.8	EXISTING IRRIGATED SOD	
4.0	WALLS	
4.1	RYHOLITE STONE WALL	7/SHEET L5.01

**MATERIALS LEGEND**


	LIMIT OF WORK
	EXISTING TREE TO REMAIN / PROTECT
	EXISTING TREE TO BE REMOVED
	EXISTING TREE TO BE REMOVED
	EXISTING TREE TO REMAIN / PROTECT
	EXISTING TREE TO BE REMOVED
	CRUSHER FINES PAVING
	NATIVE GRASS AREA
	EXISTING IRRIGATED SOD
	SHRUB / GROUNDCOVER PLANTING
	EXISTING SHRUB AREA
	STEEL EDGER

**1 TREE PROTECTION DETAIL**  
SCALE: NTS

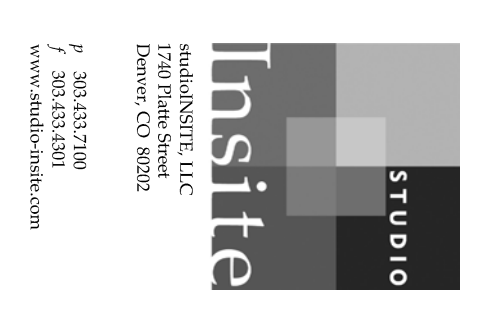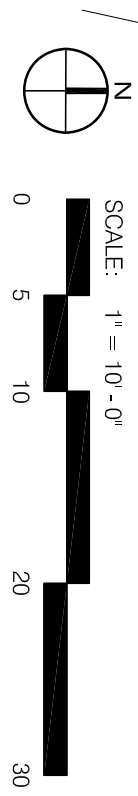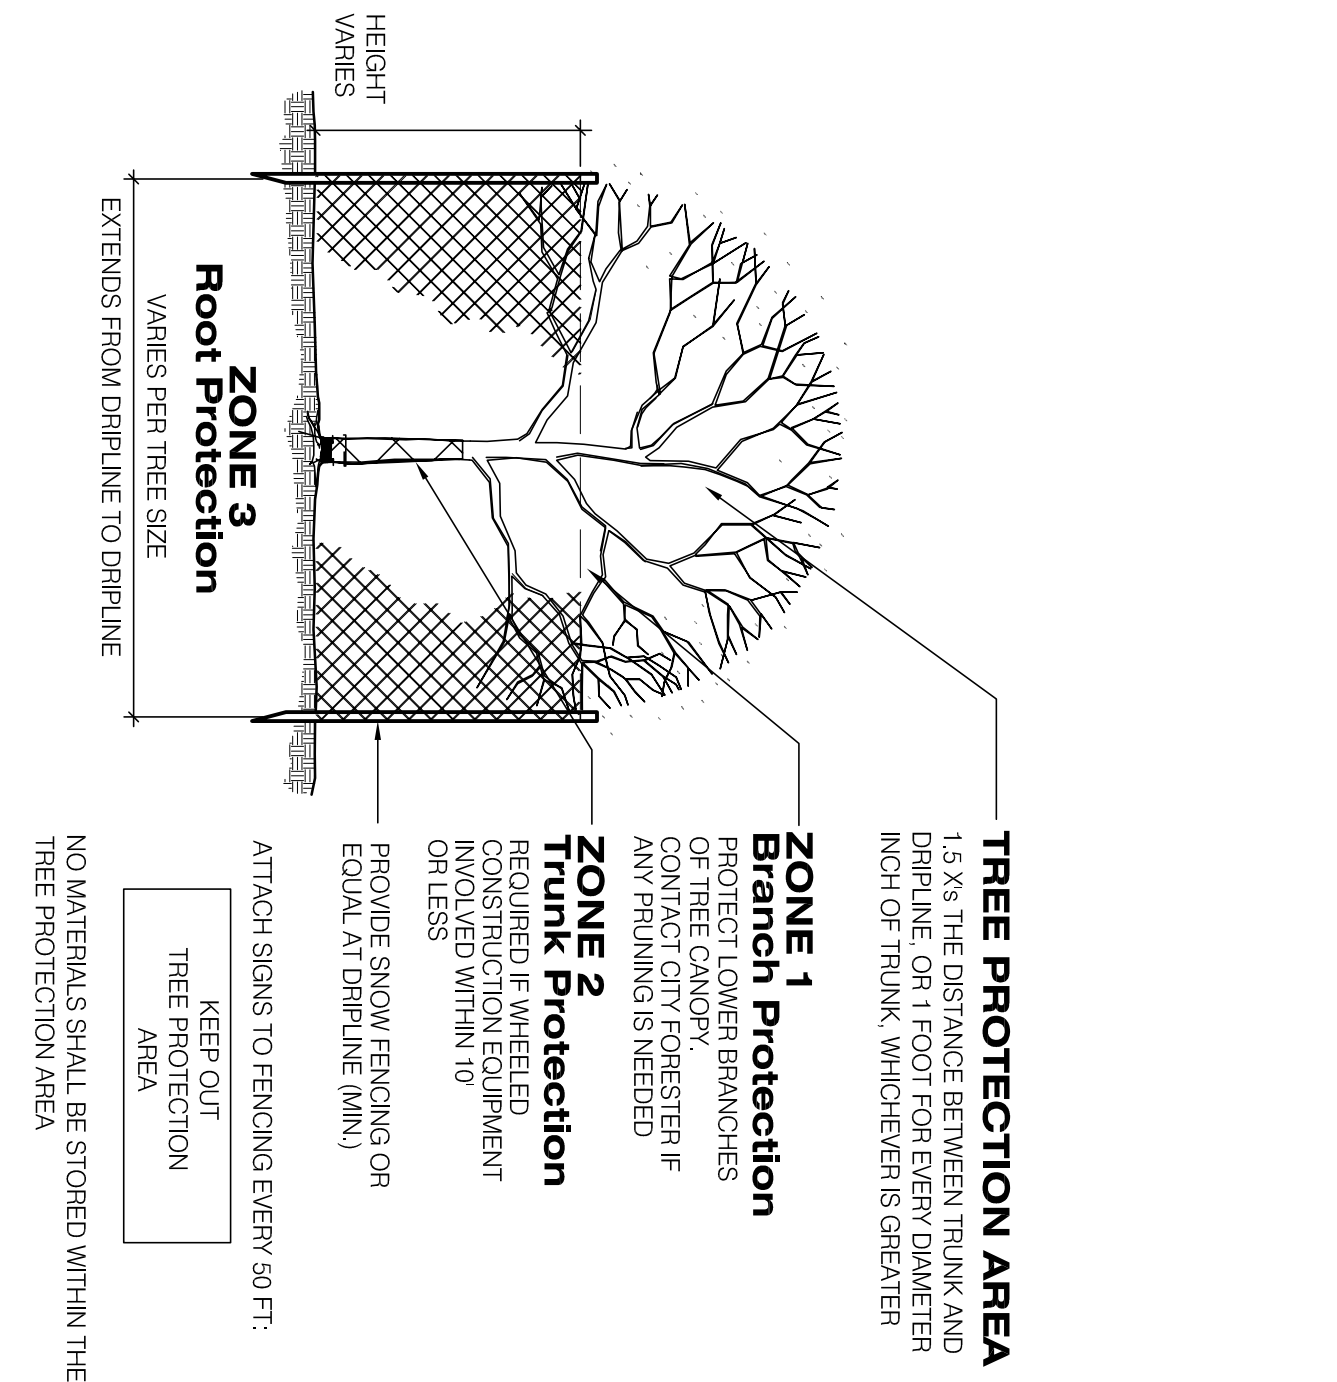

INSITE COLLEGE  
1770 Park Street  
Denver, CO 80202  
www.insite-studio.com

**McGregor Western Slope Trail**  
Colorado Springs, Colorado  
A Project For:  
**Colorado College**

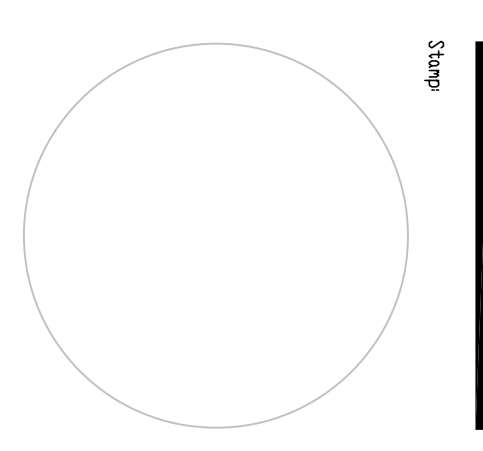

Issue Record  
100% Construction Docs 08-19-07

SI Proj No: 06-065-COMGH  
Drawn By: BRN/LLH  
Reviewed By: DR  
Plot Date: September 19, 2007  
CAD File:  
Sheet Title:  
GRADING PLAN

**L2.01**

**MATERIAL KEYNOTES**

- 00 EXISTING CONDITIONS
- 01 EXISTING TREE, TO REMAIN AND PROTECT
- 02 EXISTING TREE, TO BE REMOVED
- 03 EXISTING SHRUB AREA
- 10 PAVING
  - 1.1 CRUSHER FINES
- 20 SITE FURNISHINGS & SITE ELEMENTS
  - 2.1 BENCH (CAMPUS STANDARD)
- 30 PLANTING
  - 3.1 DECIDUOUS TREE PLANTING
  - 3.2 SHRUB PLANTING
  - 3.3 GROUNDCOVER / PERENNIAL PLANTING
  - 3.5 SHREDDED FIR FIBER MULCH
  - 3.6 STEEL EDGER
  - 3.7 NATIVE GRASS AREA
  - 3.8 EXISTING IRRIGATED SOD
- 40 WALLS
  - 4.1 RHYOLITE STONE WALL


**MATERIALS LEGEND**

- 0.1 EXISTING TREE TO REMAIN / PROTECT
- 0.2 EXISTING TREE TO BE REMOVED
- 1.1 CRUSHER FINES PAVING
- 3.7 NATIVE GRASS AREA
- 3.8 EXISTING IRRIGATED SOD
- 3.2 SHRUB / GROUNDCOVER PLANTING
- 0.3 EXISTING SHRUB AREA
- 3.6 STEEL EDGER
- LIMIT OF WORK

**PLANT LIST**

SYM	QTY	COMMON NAME	BOTANICAL NAME	PLANTING SIZE	NOTES	SPACING
<b>DECIDUOUS TREES</b>						
KCT	1	Kentucky Coffee Tree	Gymnocladus dioica	2.5' cal. B&B	Specimen	as shown
ABS	7	Autumn Brilliance Serviceberry	Aamelanchier x g. Autumn Brilliance	10'-12" B&B	Clump	as shown
<b>SHRUB / GROUNDCOVERS / PERENNIALS</b>						
ANY	21	Adams Needle	Yucca filamentosa	5 gal.	cont.	as shown
AP	15	American Plum	Prunus americana	5 gal.	cont.	as shown
FB	22	Fernbush	Chamaebatiaria millefolium	5 gal.	cont.	as shown
HCB	24	Hancock Coral Berry	Symphoricarpos x oleana	5 gal.	cont.	as shown
LGS	17	Grow-Low Sumac	Rhus aromatica 'Glo-Low'	5 gal.	cont.	as shown
MM	8	Mountain Manogary	Cercocarpus montanus	5 gal.	cont.	as shown
NWR	57	Nearly Wild Rose	Rosa woodsii	5 gal.	cont.	as shown
PP	12	Pygmy Peastrub	Caragana pygmaea	5 gal.	cont.	as shown
RS	57	Russian Sage	Mitralis multiflora	5 gal.	cont.	as shown
SFO	90	Showy 4 O'clock	Mirabilis multiflora	1 gal.	cont.	as shown
SH	89	Sunset Hyssop	Agastache rupestris	1 gal.	cont.	as shown
TWS	6	Tall Western Sagebrush	Artemisia tridentata	5 gal.	cont.	as shown


<b>GRASS &amp; WILDFLOWER MIX</b>			
30%	Bouteloua gracilis	Blue Grama	Seed
20%	Agropyron smithii	Western Wheatgrass	Seed
20%	Sporobolus cryptandrus	Sand Dropseed	Seed
15%	Boerhaavia hirsuta	Hairy Grama	Seed
10%	Hilaria janssii	Galleita Grass	Seed
5%	Linum perenne	Blue Flax	Seed

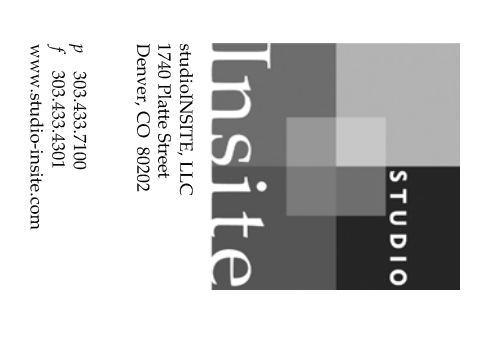

INSITE  
STUDIO  
1870 Park Street  
Denver, CO 80202  
303.534.7200  
www.insitestudio.com



**McGregor Western Slope Trail**  
Colorado Springs, Colorado  
A Project For:  
**Colorado College**

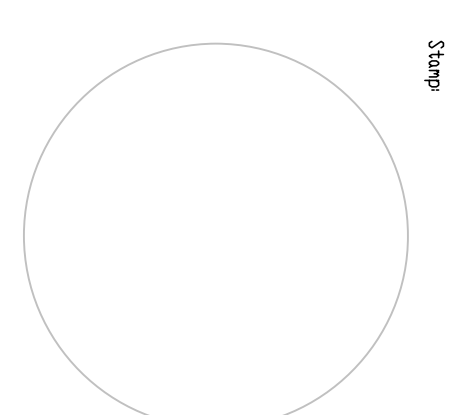

Issue Record  
100% Construction Docs 08-19-07

Drawn By: BRN/LLH  
Reviewed By: DR  
Print Date: September 19, 2007  
CAD File:  
Sheet Title: PLANTING PLAN

SI Proj. No.: 06-055 CCMGH  
Drawn By: BRN/LLH  
Reviewed By: DR  
Print Date: September 19, 2007  
CAD File:  
Sheet Title: PLANTING PLAN

**L4.01**